


SEARHC

Southeast Alaska Regional Health Consortium Mt. Edgecumbe Medical Center **Exterior Wayfinding System**

City and Borough of Sitka, Signage Variance Document

Project Number: 102562.80 April 5, 2023

nbbj

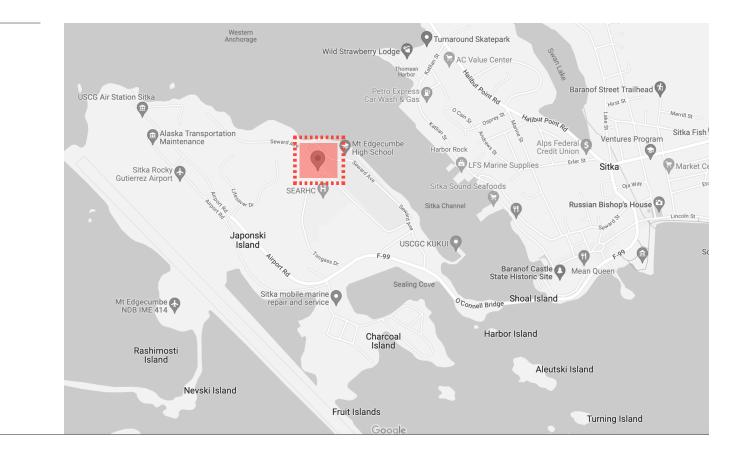

Project Team

Project Address

227 Tongass Dr.

Sitka, AK 99835

Designer

NBBJ 223 Yale Avenue North Seattle, WA 98109

Eric LeVine Principal in Charge e: elevine@nbbj.com t: 206.233.5176

Cari P. Scotkin Project Manager e: cscotkin@nbbj.com t: 206.223.5218

Yusuke Ito Designer e: yito@nbbj.com t: 206.223.2350

Architect

NBBJ 223 Yale Avenue North Seattle, WA 98109

Chuck Kolb, LEED AP Principal in Charge | Architect e: ckolb@nbbj.com t: 206.223.5009 m: 206.390.5009

Craig Matheny, RA Project Architect e: cmatheny@nbbj.com t: 206.621.2259

Heidi Aylsworth Senior Vice President/ Chief Strategy & Business Development Officer e: heidia@searhc.org t: 907.966.8833

Project SEARHC Mt. Edgecumbe Medical Center Exterior Wayfinding System

Project Information

Owner SEARHC 3100 Channel Drive Suite #300 Juneau, AK 99801


Leatha Merculieff Senior Vice President & Chief Operating Officer e: leatham@searhc.org t: 907.463.6624 m: 907.317.8836

General Contractor


ASKW Davis 6591 A St #300 Anchorage, AK 99518

James Murrell LEED® AP Project Manager e: james@davisconstructors.com o: 907.562.2336 m: 907.947.1717



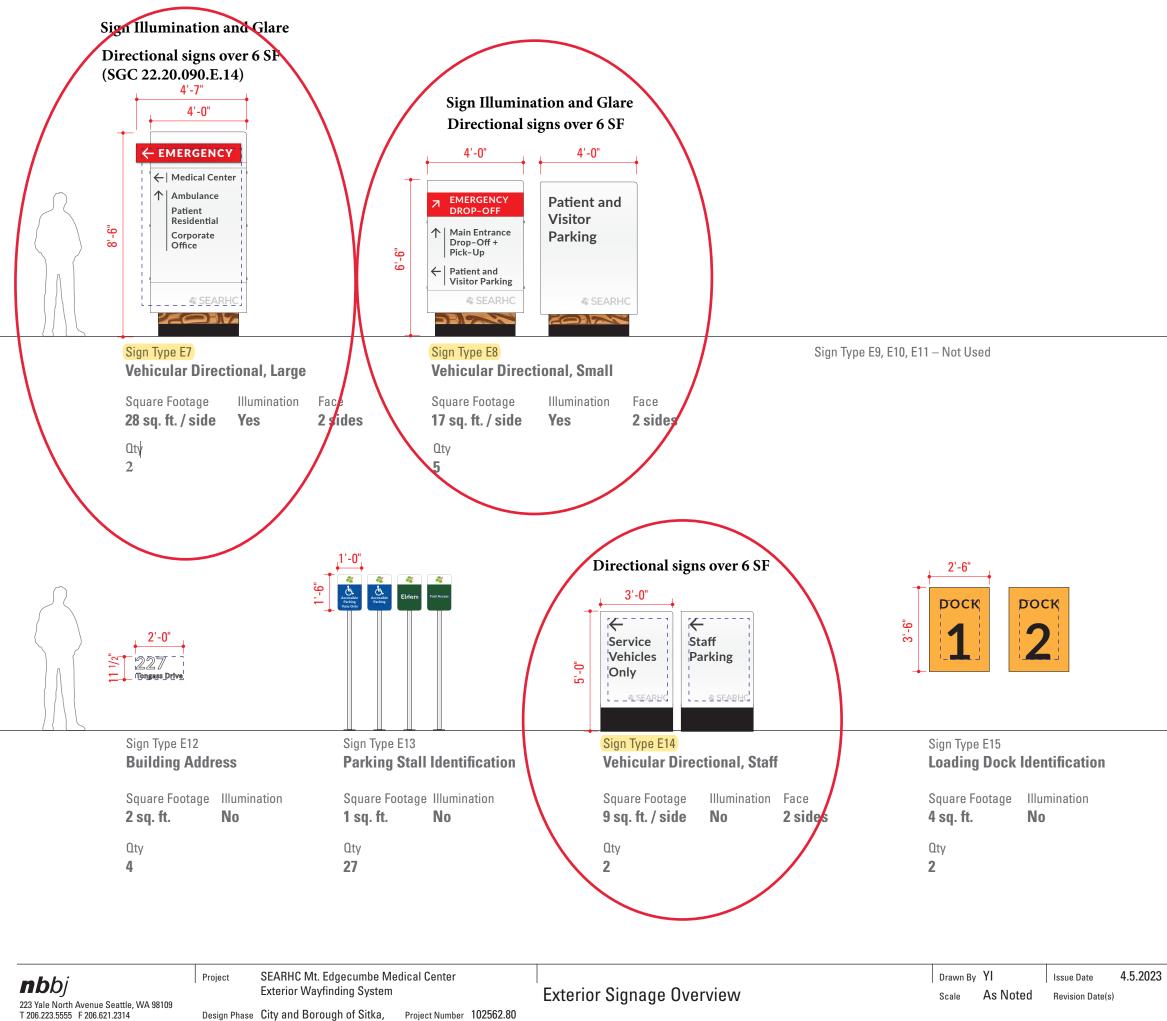

Design Phase City and Borough of Sitka, Project Number 102562.80 Signage Variance Document

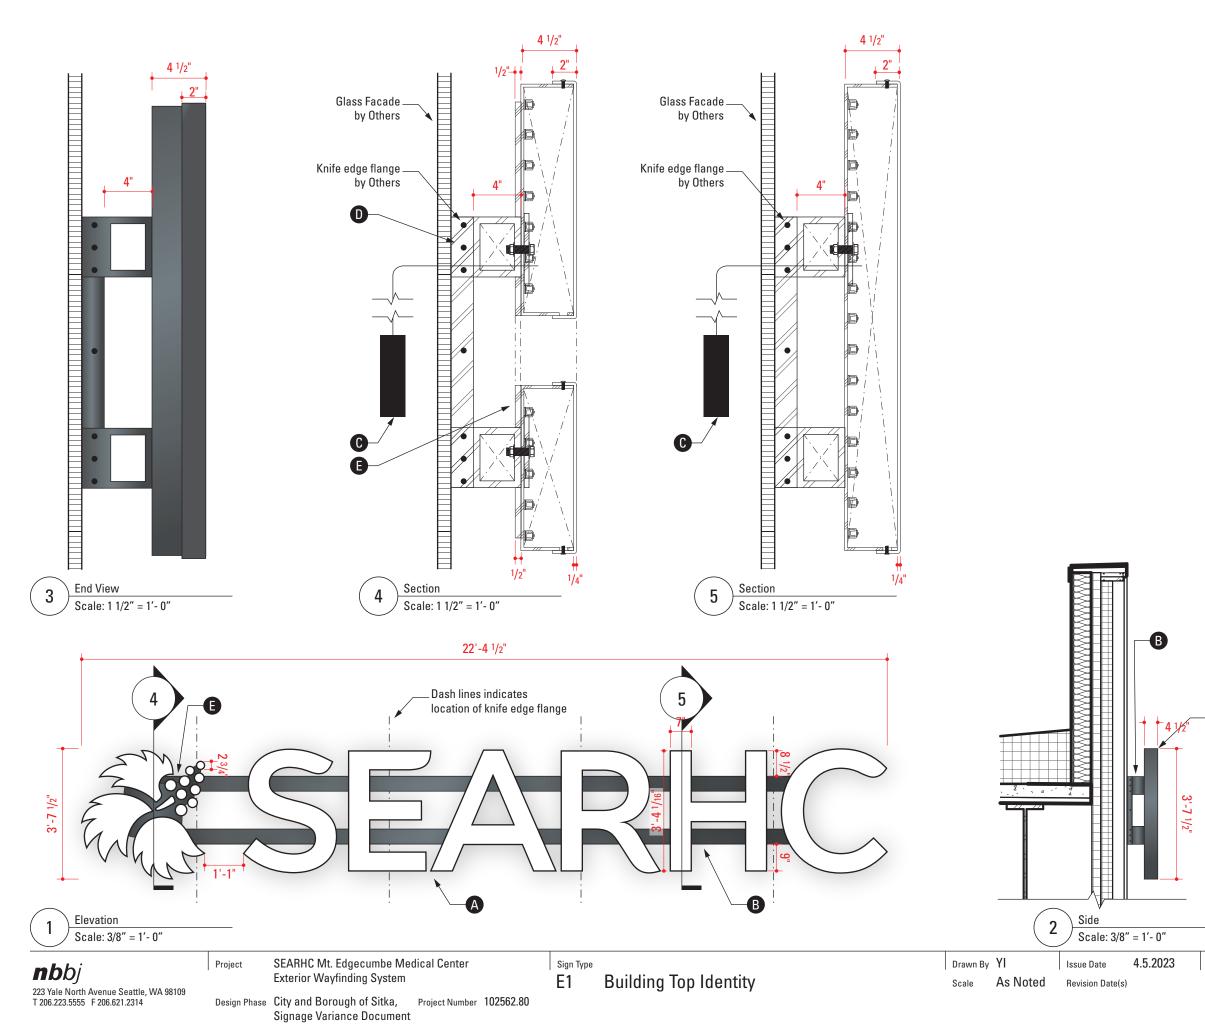

A Logo is fabricated aluminum face-lit channel letters. Face: Formed white translucent polycarbonate attached at return surface. Returns: Painted to match (including polycarbonate returns and fasteners) MP19970 Blue Slate Metallic. White LED temperature: 4,500K.

- B 6"x6"x 1/2" aluminum mounting raceway painted to match MP19970 Blue Slate Metallic.
- Power transformer. Location TBD by G.C./Fabricator.
- 1/2" plate aluminum flange welded to raceway, bolted to "knife edge" flange.
- 1/2" aluminum backing plate for logomark painted to match MP19970 Blue Slate Metallic.

General Notes

Fabricator to field verify mounting conditions prior to fabrication.

Fabricator to provide shop drawing for review and approval by Designer.

Building Top Identity on metal standoffs to be coordinated with glazed framing system joints.

Sample/Mock-ups

Fully functioning letter "R" and logomark with mounting raceway. May be used for installation if approved.



General Notes

Fabricator to field verify mounting conditions prior to fabrication.


Fabricator to provide shop drawing for review and approval by Designer.

Building Top Identity on metal standoffs to be coordinated with glazed framing system joints.





All drawings and written material appearing herein constitute original and unpublished work of the designer and may not be duplicated, used or disclosed without written consent of designer.

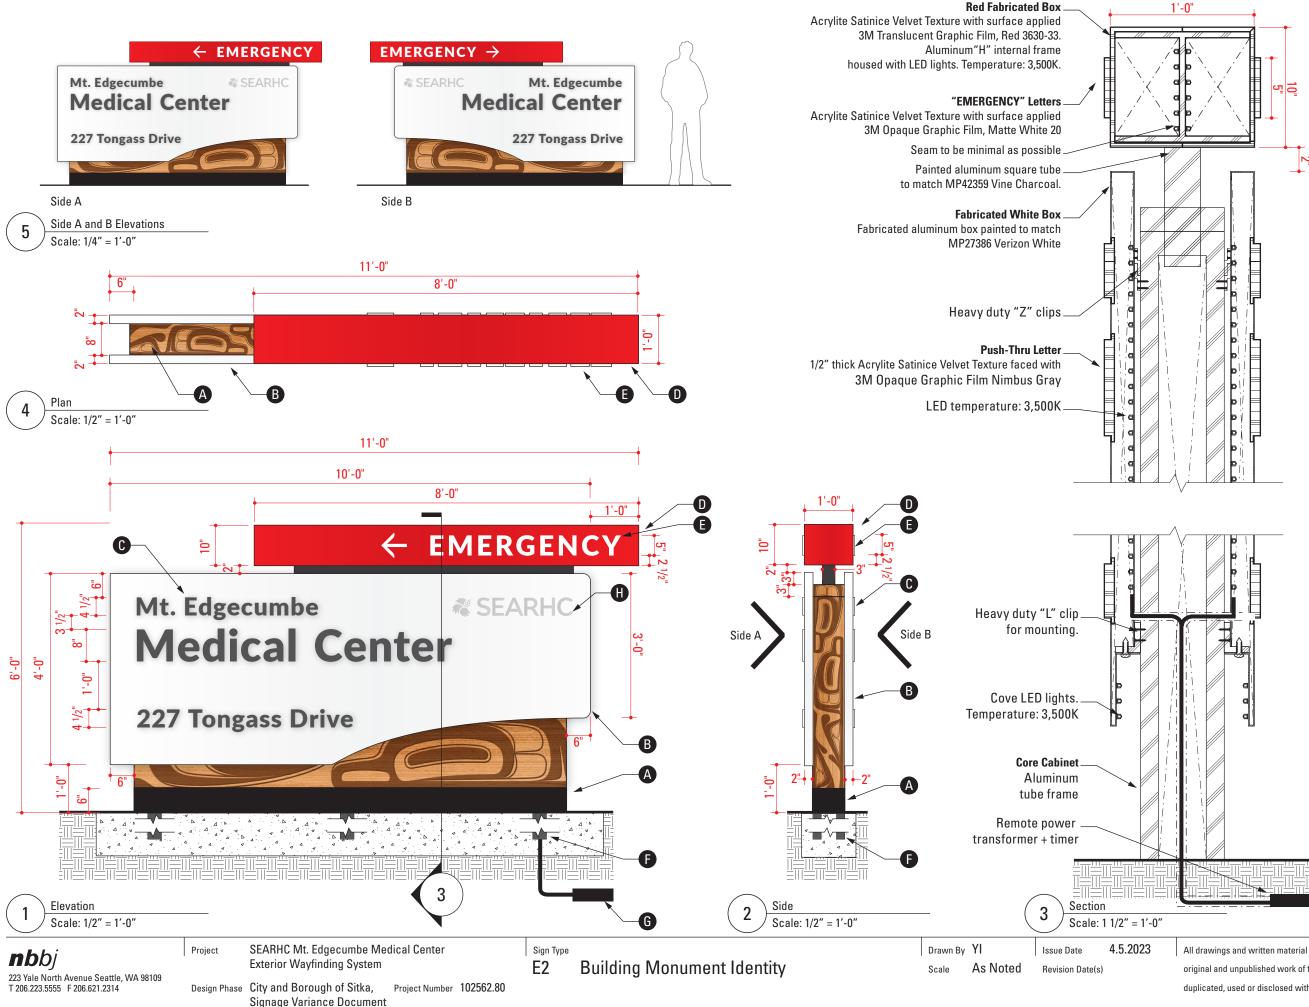

A Core cabinet is 1/8" thick aluminum panel skinned to aluminum structural frame. Wood texture, graphic pattern and black band are printed and clear coated.

B Fabricated box with internal frame is skinned with 1/8" aluminum painted to match MP27386 Verizon White. LED cove lighting on bottom and sides. LED temperature: 3,500K.

- C Letters are 1/2" thick edge lit push-thru out of Acrylite Satinice, Velvet Texture, White WM32 SC, faced with 3M Opaque Graphic Film Nimbus Gray. LED temperature: 3,500K. Font: Lato, Black. Tracking: 35.
- D Internally lit fabricated box with "H" aluminum frame is skinned with Acrylite Satinice Velvet Texture, White WM32 SC faced with with 3M Translucent Graphic Film, RED 3630-33. LED temperature: 3,500K.
- E Letters are waterjet cut Acrylite Satinice Velvet Texture, White WM32 SC, faced 3M Opaque Graphic Film, Matte White 20. Font: Lato, Black. Tracking: 100.




- **F** Securely mount to concrete footing, as required by engineering.
- **G** Remote power transformer with timer. Location TBD by Fabricator and G.C.
- H Logo is screen printed to match Pantone Cool Grey 11C.


General Notes

Fabricator to field verify mounting conditions prior to fabrication.


Fabricator to provide shop drawing for review and approval by Designer.

Sample/Mock-ups 3'x3' partial full scale mock-up.

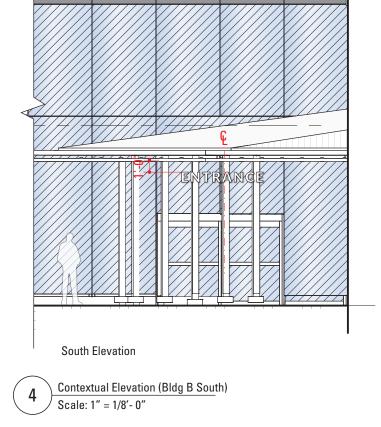

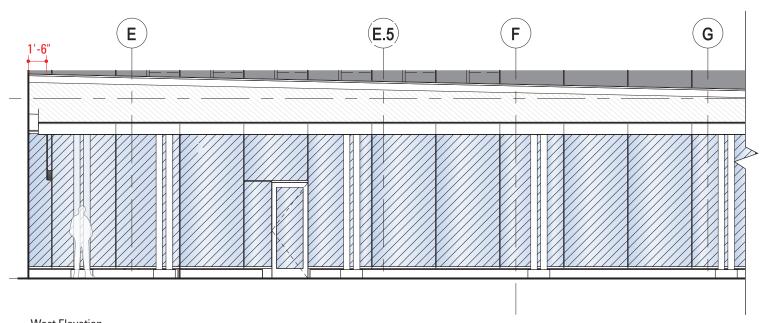

West Elevation

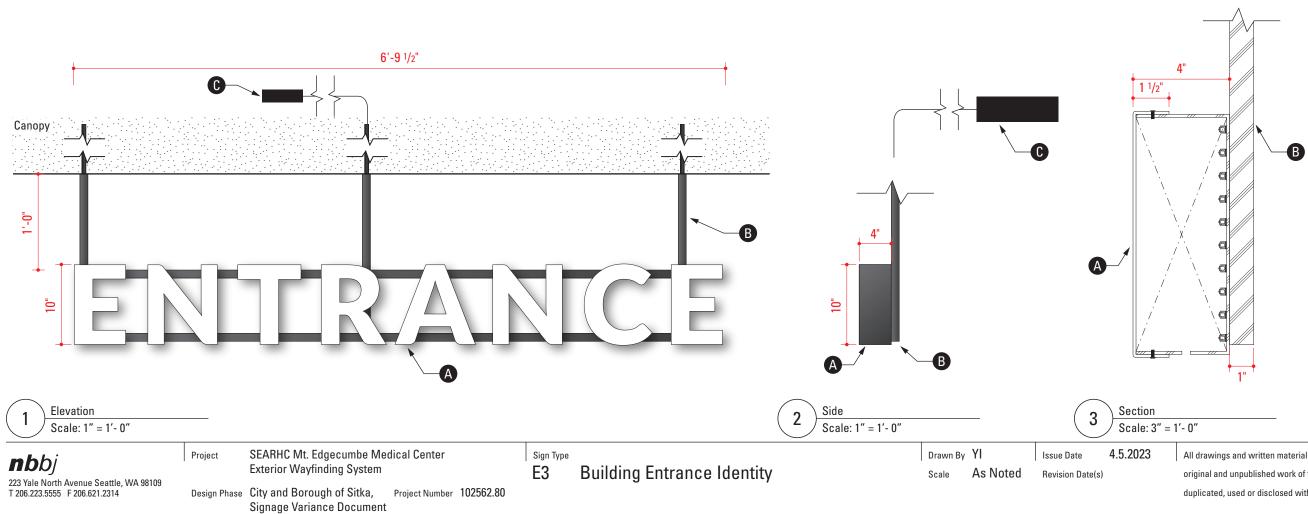

Fabrication Notes

A Logo is fabricated face-lit channel letters. Face: Formed white translucent polycarbonate attached at return surface. Returns: Painted to match, including polycarbonate returns and fasteners, MP19970 Blue Slate Metallic. LED temperature: 4,500K. Font: Lato, Black. Tracking: 100.




B 1"x1" aluminum mounting raceway painted to match MP19970 Blue Slate Metallic.

C Remote power transformer. Location TBD by G.C./Fabricator.

General Notes

Fabricator to field verify mounting conditions prior to fabrication.

Fabricator to provide shop drawing for review and approval by Designer.

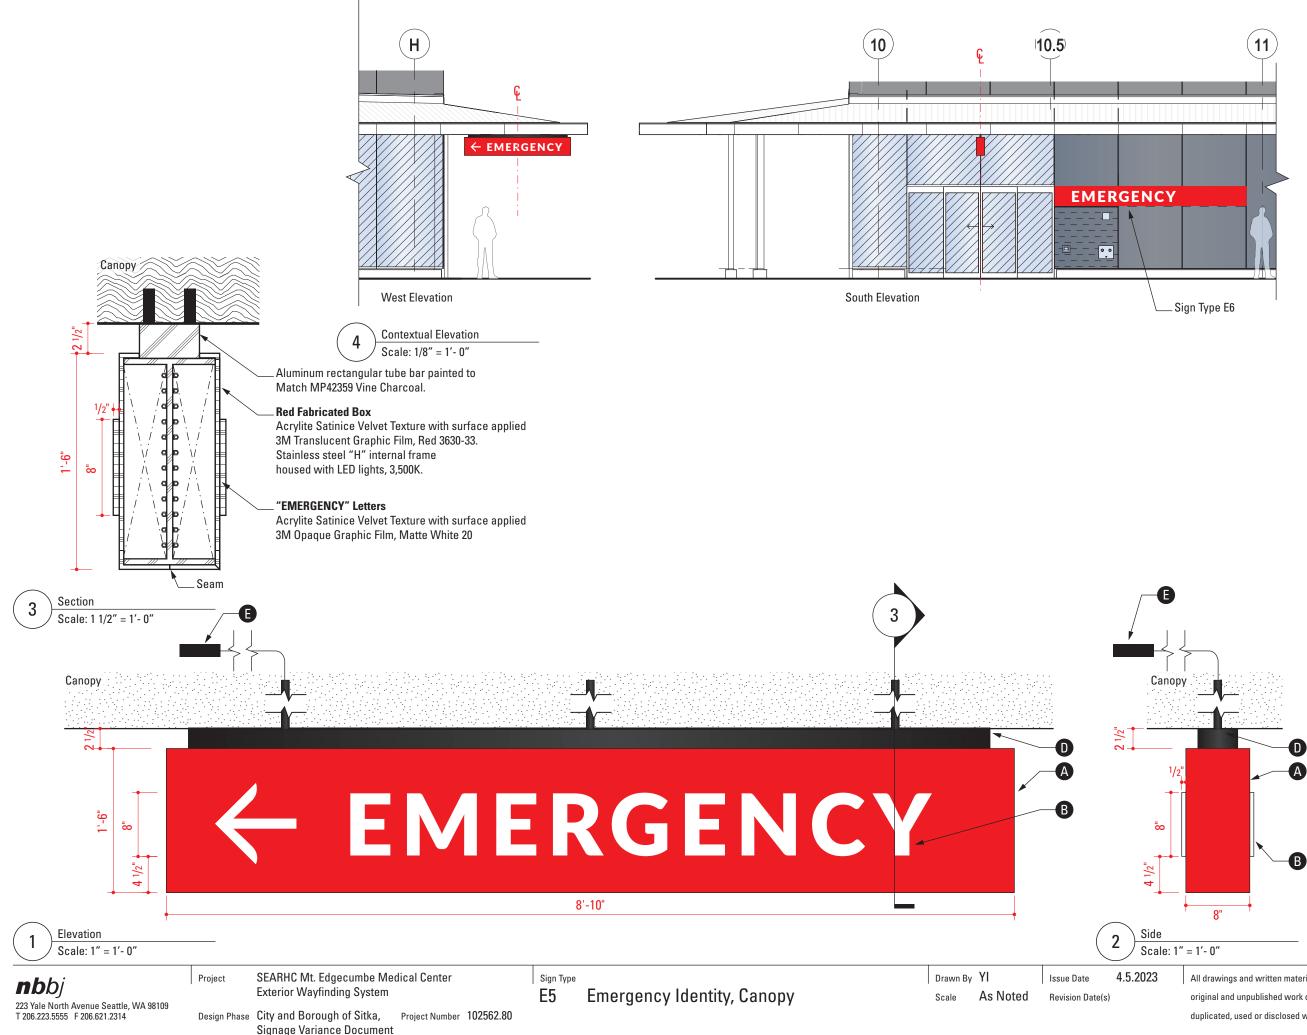

A Internally lit fabricated box with "H" aluminum frame is skinned with Acrylite Satinice Velvet Texture, White WM32 SC faced with 3M Translucent Graphic Film, RED 3630-33. LED temperature: 3,500K.



B Letters are waterjet cut Acrylite Satinice Velvet Texture, White WM32 SC, faced 3M Opaque Graphic Film, Matte White 20. Font: Lato, Black. Tracking: 100.



C 1"x1" aluminum rectangular tube painted to match MP42359 Vine Charcoal.



Power transformer. Location TBD by D G.C./Fabricator.

General Notes


Fabricator to field verify mounting conditions prior to fabrication.

Fabricator to provide shop drawing for review and approval by Designer.

Gr.

Sample/Mock-ups

Functioning partial mock-up including arrow and "E".

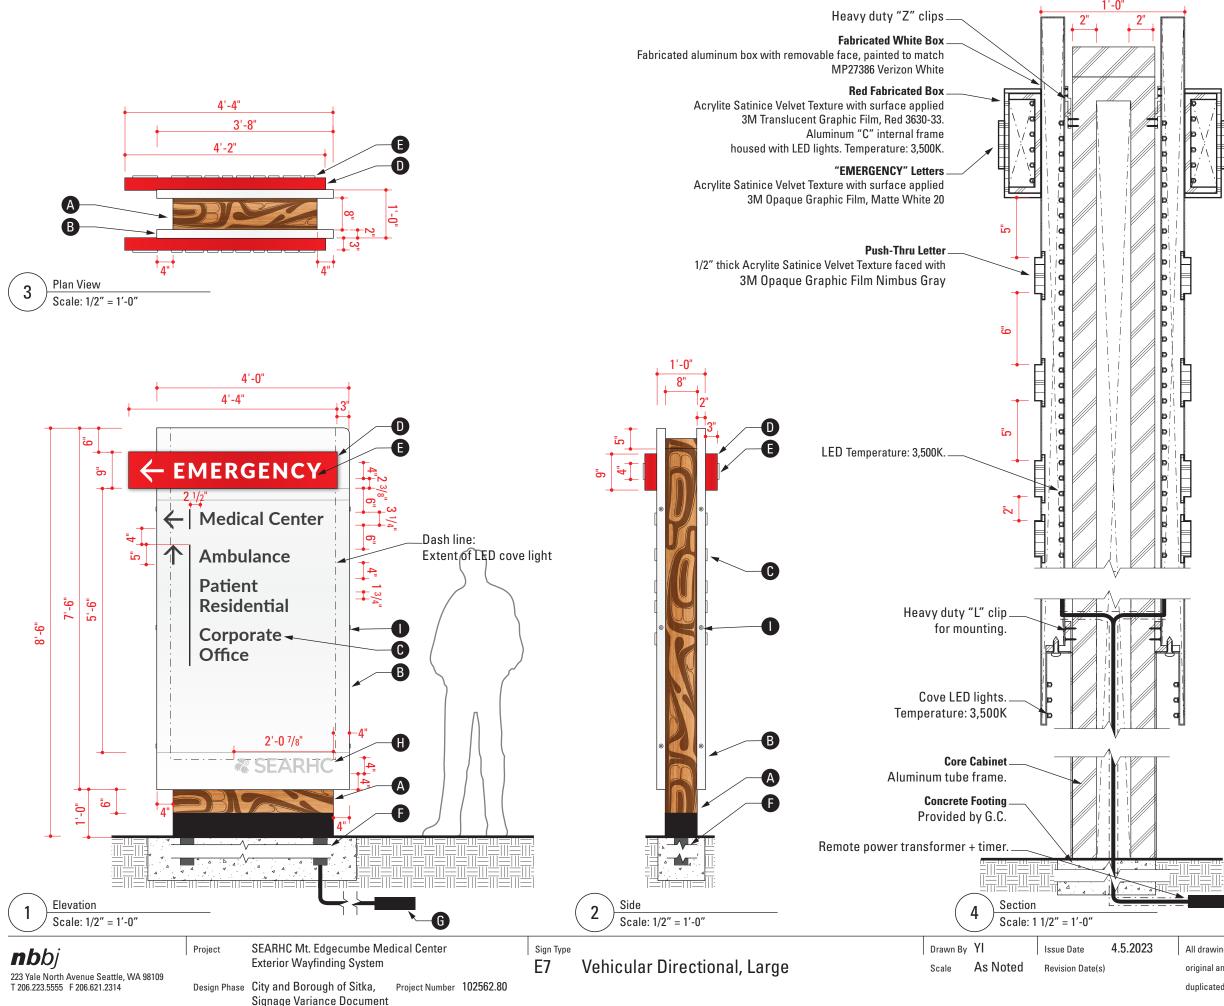



A Core cabinet is 1/8" thick aluminum panel skinned to stainless steel structural frame. Wood texture, graphic pattern and black band are printed and clear coated.



B Fabricated box with internal frame is skinned with 1/8" removable aluminum panel painted to match MP27386 Verizon White. LED cove lighting on bottom and sides. LED temperature: 3,500K.

C Letters are 1/2" thick edge lit push-thru out of Acrylite Satinice, Velvet Texture, White WM32 SC, faced with 3M Opaque Graphic Film Nimbus Gray. LED temperature: 3,500K. Font: Lato, Bold. Tracking:10.

D Internally lit fabricated box with "C" aluminum frame is skinned with Acrylite Satinice Velvet Texture, White WM32 SC faced with 3M Translucent Graphic Film, RED 3630-33. LED temperature: 3,500K.

E Letters are waterjet cut Acrylite Satinice Velvet Texture, White WM32 SC, faced 3M Opaque Graphic Film, Matte White 20. Font: Lato, Black. Tracking: 100.



F Securely mount to concrete footing.

G Remote power transformer with timer. Location TBD by Fabricator and G.C.

H Logo is screen printed to match Pantone Cool Grey 11C.


Countersunk screws painted to match MP27386 Verizon White.

General Notes


Fabricator to field verify mounting conditions prior to fabrication.

Fabricator to provide shop drawing for review and approval by Designer.

Digital Artwork provided by Designer.

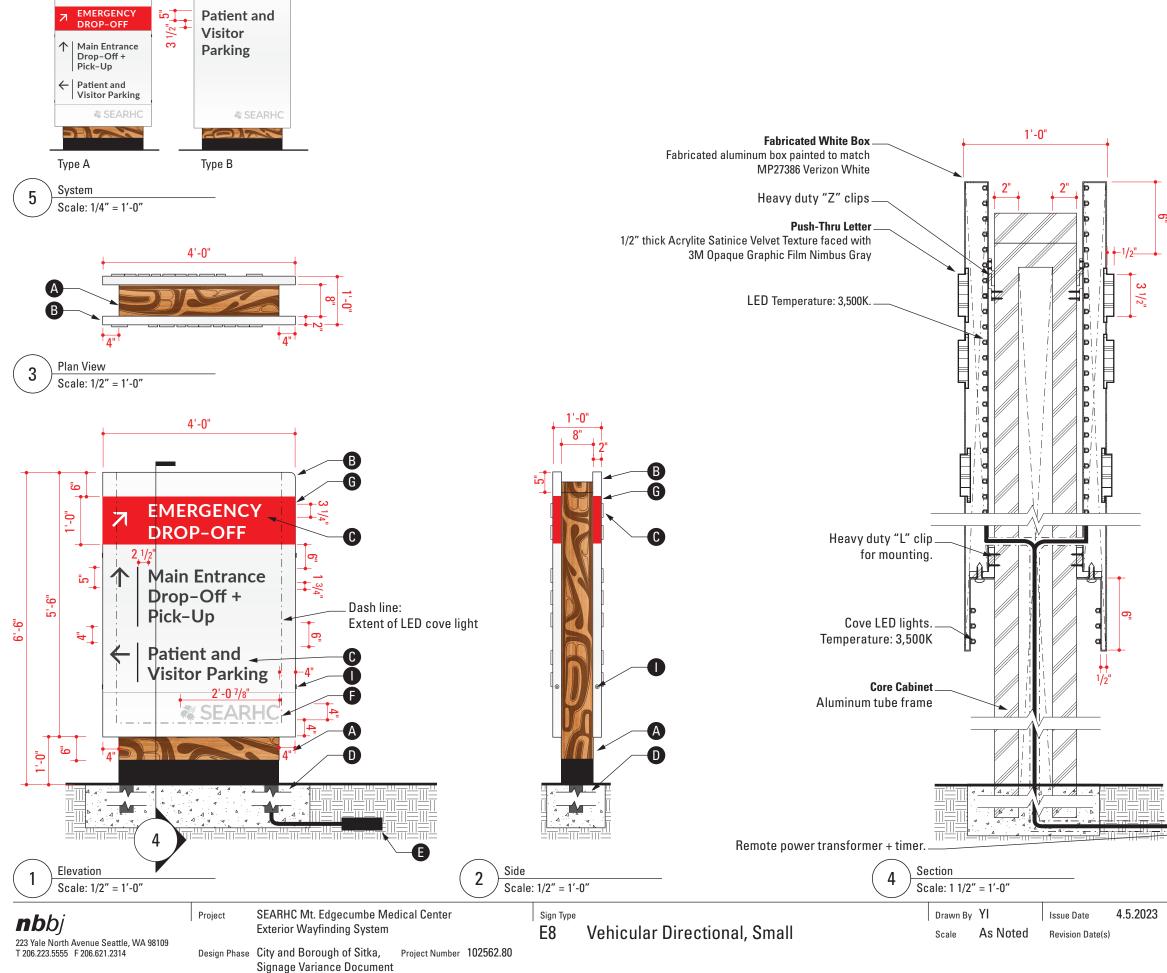

A	Fabrication Notes Core cabinet is 1/8" aluminum skinned to aluminum structural frame. Wood texture, graphic pattern and black band are printed and clear-coated.
8	Fabricated box with internal frame is skinned with 1/8" removable aluminum panel painted to match MP27386 Verizon White. LED cove lighting on bottom and sides. LED temperature: 3,500K.
C	Letters are 1/2" thick edge lit push-thru out of Acrylite Satinice, Velvet Texture, White WM32 SC, faced with 3M Opaque Graphic Film Nimbus Gray. LED temperature: 3,500K. Font: Lato, Black. Tracking: 35.
0	Securely mount to concrete footing as required per engineering.
0	Power transformer with timer. Location TBD by Fabricator and G.C.
G	Logo is screen printed to match Pantone Cool Grey 11C.
G	Horizontal band is painted to match Pantone 1797 C.
0	Countersunk screws painted to match MP27386 Verizon White.
	General Notes Fabricator to field verify mounting conditions prior to fabrication.
	Fabricator to provide shop drawing for review and approval by Designer
	Digital Artwork provided by Designer.

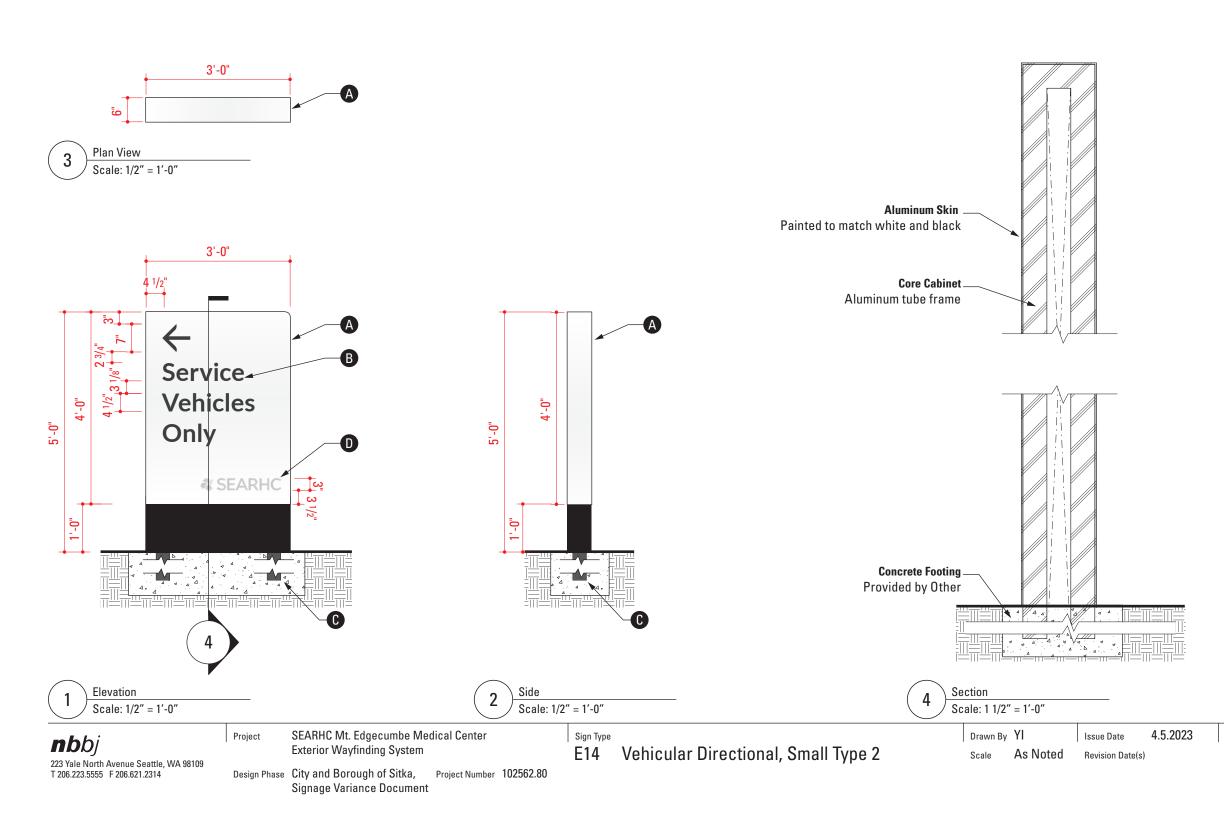



A Core cabinet is 1/8" thick aluminum skinned to aluminum structural frame. Paint to match MP27386 Verizon White and MP

B Letters and arrow are plotter cut 3M Opaque Graphic Film Nimbus Gray 101. Font: Lato, Bold. Tracking: 35.



C Securely mount to concrete footing as required per engineering.



D Logo is screen printed to match Pantone Cool Grey 11C.

General Notes

Fabricator to field verify mounting conditions prior to fabrication.

Fabricator to provide shop drawing for review and approval by Designer.





Sign Type E1 Building Top Identity (South)

Sign Type E1 Building Top Identity (North)



nbbj 223 Yale North Avenue Seattle, WA 98109 T 206.223.5555 F 206.621.2314

SEARHC Mt. Edgecumbe Medical Center Exterior Wayfinding System Project


Location Plan Renderings, Day View Drawn By YI 4.5.2023 Issue Date As Noted Scale Revision Date(s)


Design Phase City and Borough of Sitka, Project Number 102562.80 Signage Variance Document

Renderings are for context purposes only. They do not reflect the current architecture/landscape design.



All drawings and written material appearing herein constitute original and unpublished work of the designer and may not be duplicated, used or disclosed without written consent of designer.

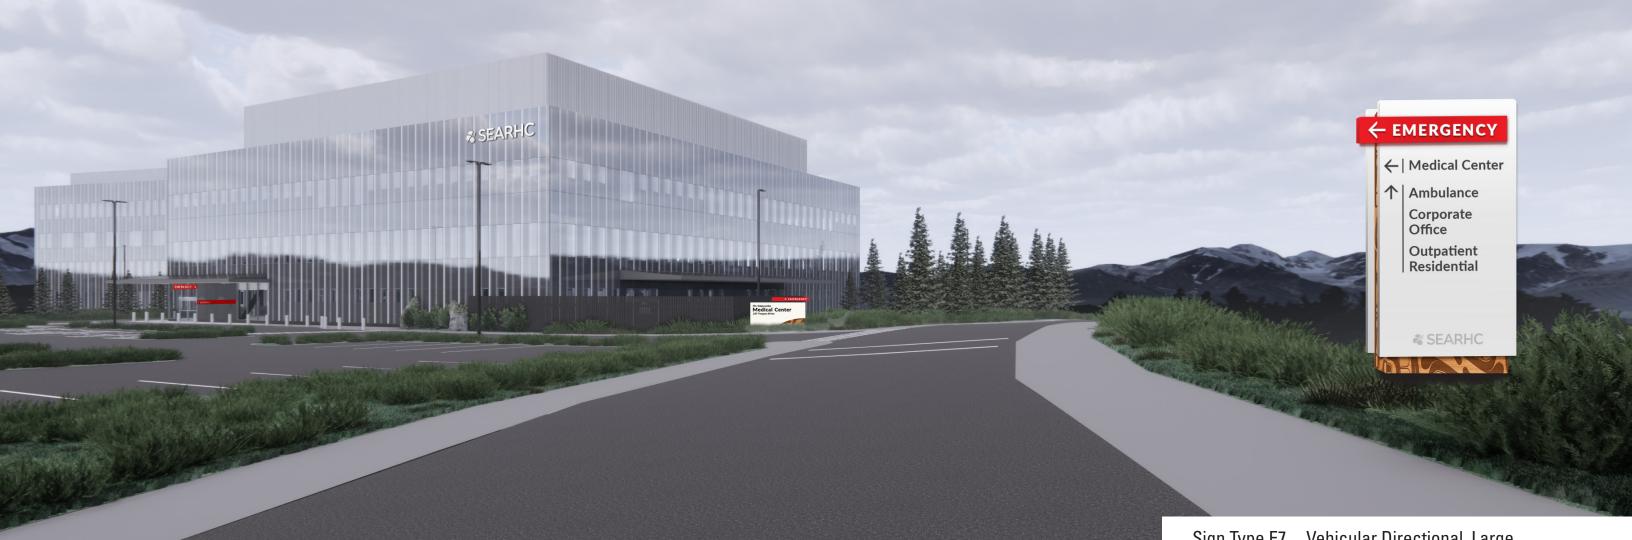

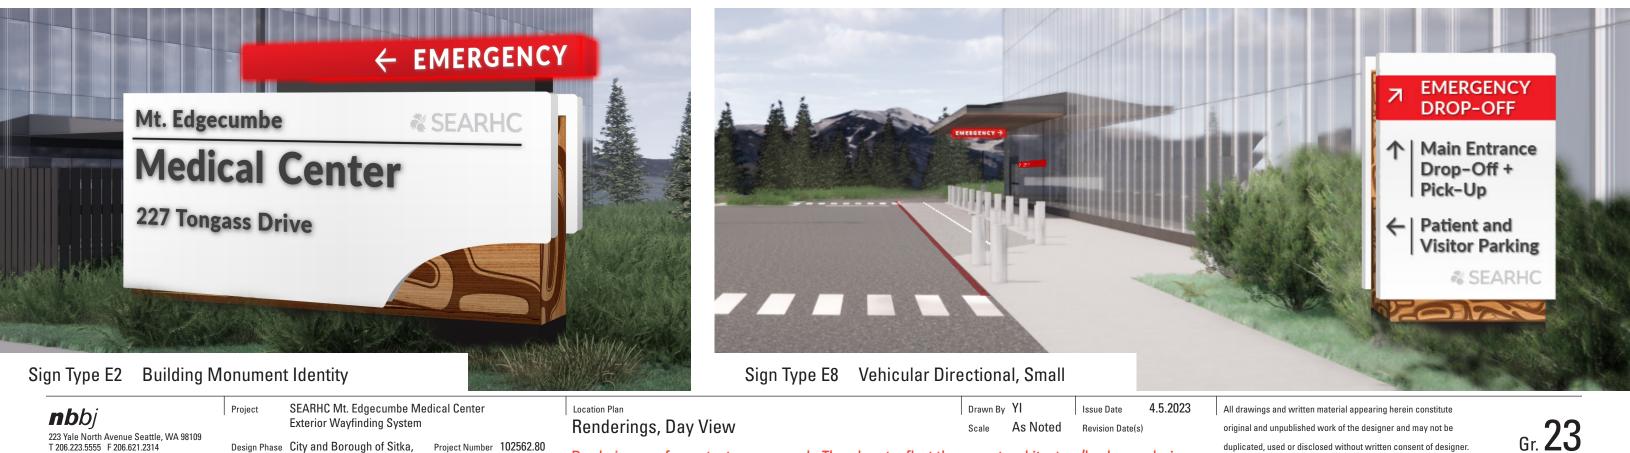

Design Phase City and Borough of Sitka, Project Number 102562.80 Signage Variance Document

Renderings are for context purposes only. They do not reflect the current architecture/landscape design.

Sign Type E7 Vehicular Directional, Large

duplicated, used or disclosed without written consent of designer.









nbbj 223 Yale North Avenue Seattle, WA 98109 T 206.223.5555 F 206.621.2314

SEARHC Mt. Edgecumbe Medical Center Exterior Wayfinding System Project

Location Plan Renderings, Day View Drawn By YI 4.5.2023 Issue Date As Noted Scale Revision Date(s)

Design Phase City and Borough of Sitka, Project Number 102562.80 Signage Variance Document

Renderings are for context purposes only. They do not reflect the current architecture/landscape design.

All drawings and written material appearing herein constitute original and unpublished work of the designer and may not be duplicated, used or disclosed without written consent of designer.





Sign Type E13 Parking Stall Identification

SEARHC Mt. Edgecumbe Medical Center Exterior Wayfinding System Project

Location Plan Renderings, Day View Drawn By YI 4.5.2023 Issue Date As Noted Scale Revision Date(s)

Design Phase City and Borough of Sitka, Project Number 102562.80 Signage Variance Document

Renderings are for context purposes only. They do not reflect the current architecture/landscape design.





Sign Type E1 Building Top Identity (South)

Building Top Identity (North) Sign Type E1



nbbj 223 Yale North Avenue Seattle, WA 98109 T 206.223.5555 F 206.621.2314

SEARHC Mt. Edgecumbe Medical Center Exterior Wayfinding System Project

Design Phase City and Borough of Sitka, Project Number 102562.80 Signage Variance Document

Location Plan Renderings, Night View Drawn By YI 4.5.2023 Issue Date Scale As Noted Revision Date(s)

Renderings are for context purposes only. They do not reflect the current architecture/landscape design. The renderings diagrammatically illustrate the lighting.

All drawings and written material appearing herein constitute original and unpublished work of the designer and may not be duplicated, used or disclosed without written consent of designer.





223 Yale North Avenue Seattle, WA 98109 T 206.223.5555 F 206.621.2314

Design Phase City and Borough of Sitka, Project Number 102562.80


Signage Variance Document

Renderings, Night View

Renderings are for context purposes only. They do not reflect the current architecture/landscape design. The renderings diagrammatically illustrate the lighting.

Sign Type E7 Vehicular Directional, Large

duplicated, used or disclosed without written consent of designer.

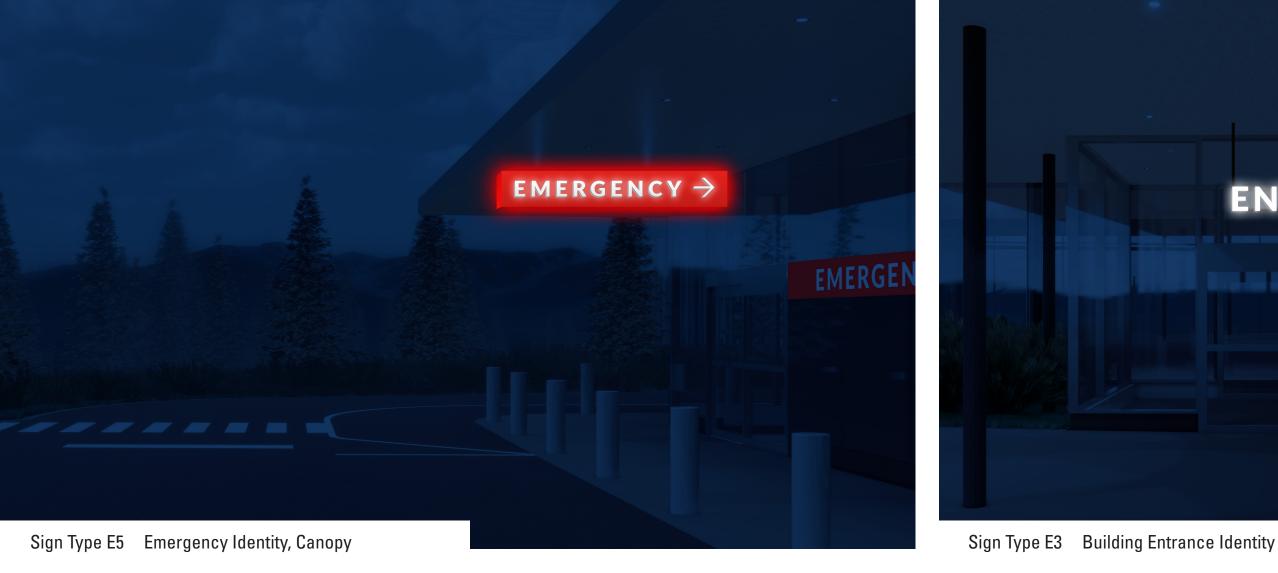



4.5.2023 Issue Date

nbbj 223 Yale North Avenue Seattle, WA 98109 T 206.223.5555 F 206.621.2314

SEARHC Mt. Edgecumbe Medical Center Project Exterior Wayfinding System

Location Plan **Renderings**, Night View Drawn By YI Scale As Noted Revision Date(s)

Design Phase City and Borough of Sitka, Project Number 102562.80 Signage Variance Document

Renderings are for context purposes only. They do not reflect the current architecture/landscape design. The renderings diagrammatically illustrate the lighting.



All drawings and written material appearing herein constitute original and unpublished work of the designer and may not be duplicated, used or disclosed without written consent of designer.